BH HOLDING LLC 8306 WILSHIRE BLVD, SUITE 208 BEVERLY HILLS, CA 90211

### **ARCHITECTURAL DESIGNER**

B RAEEN CONSTRUCTION INC 11040 SANTA MONICA BLVD, SUITE 326 LOS ANGELES, CA 90025 BRAEEN@AOL.COM

#### LAND USE CONSULTANT

nūr - DEVELOPMENT | CONSULTING 864 S ROBERTSON BLVD, 3RD FLOOR LOS ANGELES, CA 90035 DANIEL@NURDEVELOPMENT.COM

#### LANDSCAPE ARCHITECT

SEED GROUP 1505 BORDER AVENUE TORRANCE, CA 90501 ART@SEEDGROUPLA.COM





REVISIONS BY

VICINITY MAP

Airdrome St

PROJECT SUMMARY BY TUP DEVELOPMENT | CONSULTIN

PROJECT DESCRIPTION
A NEW S-STORY, 56' HIGH, 15-UNIT MULTI-FAMILY BUILDING WITH 3 UNITS SET
ASIDE AS RESTRICTED AFFORDABLE UNITS AND PARKING ON THE GROUND
FLOOR AND 1 SUBTERRANEAN PARKING LEVEL.

APN 4303-003-017

REQUESTED ENTITLEMENTS
3 ON-MENU DENSITY BONUS INCENTIVES TO ALLOW A HEIGHT INCREASE OF 11-FEET, A 35% INCREASE IN FAR, AND A 20% REDUCTION IN THE NORTHERLY SIDE YARD SETBACK.

LOT AREA LOT AREA 1/2 THE ALLEY LOT AREA FOR DENSITY ZONING R3-1-0 LOT AREA FOR DENSITY

LOT AREA FOR DENSITY

DENSITY RATIO FOR R3

BASE DENSITY: 8.074 / 800 = 10.09 =

DB BASE DENSITY (ROUND UP)

DB DENSITY BONUS: 35% x 11 = 3.85 =

MAX DENSITY: 11+4 = 1 DU/800 SF

VLI UNITS REQUIRED PER DB: 11% X 11 = 1.2 = AFFORDABLE REQUIRED PER LAHD RUD: 2 @ VLI + 1 @ LI = TOTAL PROVIDED UNITS

LEGAL DESCRIPTION

LOT NO. 69 - 70 OF AIRDROME HEIGHT TRACT RECORDED IN MB 71-21 PAGES 632 IN THE CITY OF LOS ANGELES. COUNTY OF LOS ANGELES, STATE OF CALIFORNIA.

APN: 4303003017

RESIDENTIAL UNIT MIX 1-BR 2-BR 3-BR TOTAL FLOOR AREA & FAR (ZONING) BUILDABLE AREA ALLOWABLE FAR PER R3-1 MAX SQUARE FOOTAGE: 4,913 x 3 = 35% INCREASE PER DB INCENTIVE MAX FLOOR AREA ALLOWED TOTAL ELOOR AREA PROVIDED 17 378 HEIGHT / STORIES

MAX HEIGHT / STORIES PER R3-1

MAX HEIGHT W/ DB INCENTIVE: 45 + 11 = PROPOSED HEIGHT

AUTO PARKING RESIDENTIAL REQUIRED PER LAMC 12.21.A4 1-BR: 6 x 1.5 2 & 3-BR: 9 x 2 TOTAL PARKING REQUIRED T-1 RESIDENTIAL REQUIRED PER CA GOV CODE SECTION 65915(p)(1) 1-BR: 6 x 1 2 & 3-BR: 9 x 1.5 TOTAL PARKING REQUIRED: 6 + 13.5 = 19.5 = 13.5 TOTAL PARKING PROVIDED: 4 COMPACT + 16 STANDARD 20 EV PARKING REQUIREMENT (30%) EVCS (FULL INSTALL) (10%) EVSE (FUTURE INSTALL) SIKE DVDKING BIKE PARKING

RES LONG-TERM REQUIRED: (15/1) =

RES SHORT-TERM REQUIRED: (15/10) =

RESIDENTIAL LONG-TERM PROVIDED

RESIDENTIAL SHORT-TERM PROVIDED TOTAL BIKE PARKING REQUIRED TOTAL BIKE PARKING PROVIDED DEN SPACE PEN SPACE OPEN SPACE REQUIRED 1-BR (2 HABITABLE ROOMS): 6 X 100 2-BR (3 HABITABLE ROOMS): 3 X 125 3-BR (4 HABITABLE ROOMS): 6 X 175 TOTAL REQUIRED OPEN SPACE PER LAMO OPEN SPACE PROVIDED 2NF FLOOR REC ROOM (MAX 25%) ROOF DECK BALCONIES: 9 x 50 TOTAL PROVIDED SQUARE FOOTAGE COMMON OPEN SPACE REQUIRED (50% OF REQ'D): 50% x 2,025 = COMMON OPEN SPACE PROVIDED:

15-FEET 6.4-FEET\* 8-FEET 15-FEET\*\*

REQUIRED # OF TREES: 15 DU / 4 TREES TREES PROVIDED

\* 20% REDUCTION VIA DB ON-MENU INCENTIVE \*\* TO CL OF ALLEY

SETBACK LOCATION FRONT YARD PREUSS SIDE YARD NORTHERLY PL

SIDE YARD AIRDROME REAR YARD ALLEY

SETBACKS

56-FEET / NO LIMIT 56-FEET / 5-STORIES

REQUIRED LANDSCAPE: 25% X 1,580 (COMMON OPEN SPACE) PROVIDED LANDSCAPE

A-1.1 A-1.2 A-1.3 A-1.4 A-2 A-3 A-4 A-5 A-6 A-7 1ST FLOOR PLAN 2ND FLOOR PLAN 3RD FLOOR PLAN 4TH FLOOR PLAN 5TH FLOOR PLAN A-8 A-9 A-10 A-11 A-12 A-13 ROOF PLAN EAST ELEVATION WEST ELEVATION NORTH ELEVATION SOUTH ELEVATION SECTIONS A-A A-14 SECTIONS B-B

NO.

**ARCHITECTURAL** 

SHEET TITLE

SITE PLAN OPEN SPACE DIAGRAM

BUILDARI E AREA DIAGRAN

INDEX OF DWG'S PROJECT SUMMARY

LEGAL DESCRIBTION

COVERSHEET

FLOOR AREA DIAGRAM BUILDING AREA DIAGRAM RASEMENT PLAN LANDSCAPE NO. SHEET TITLE


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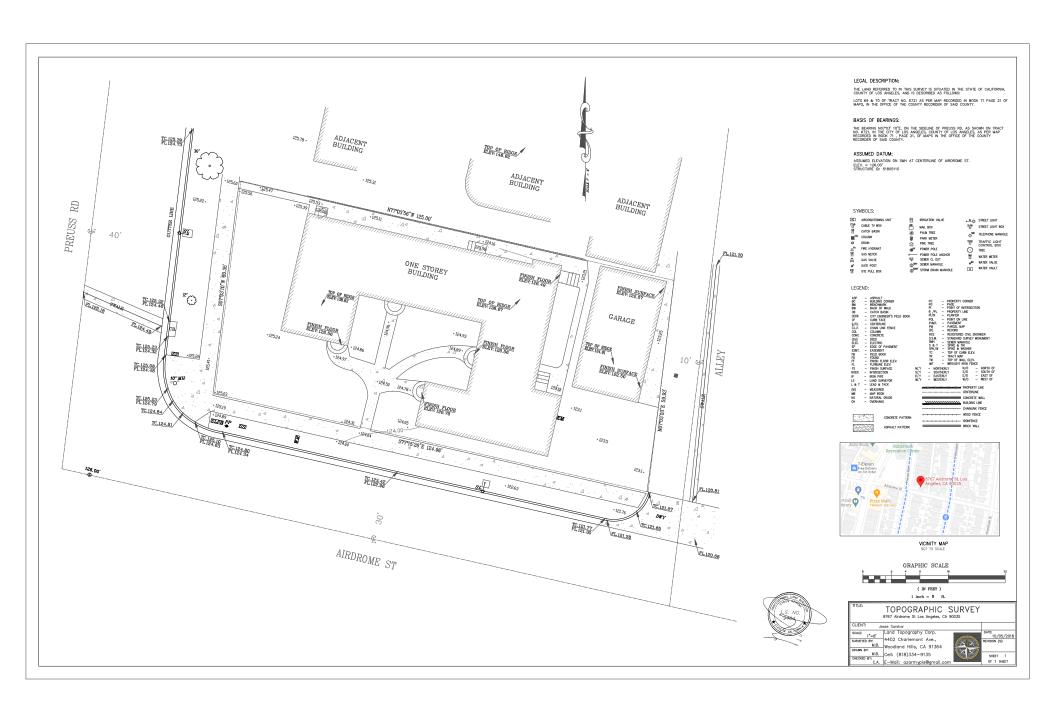
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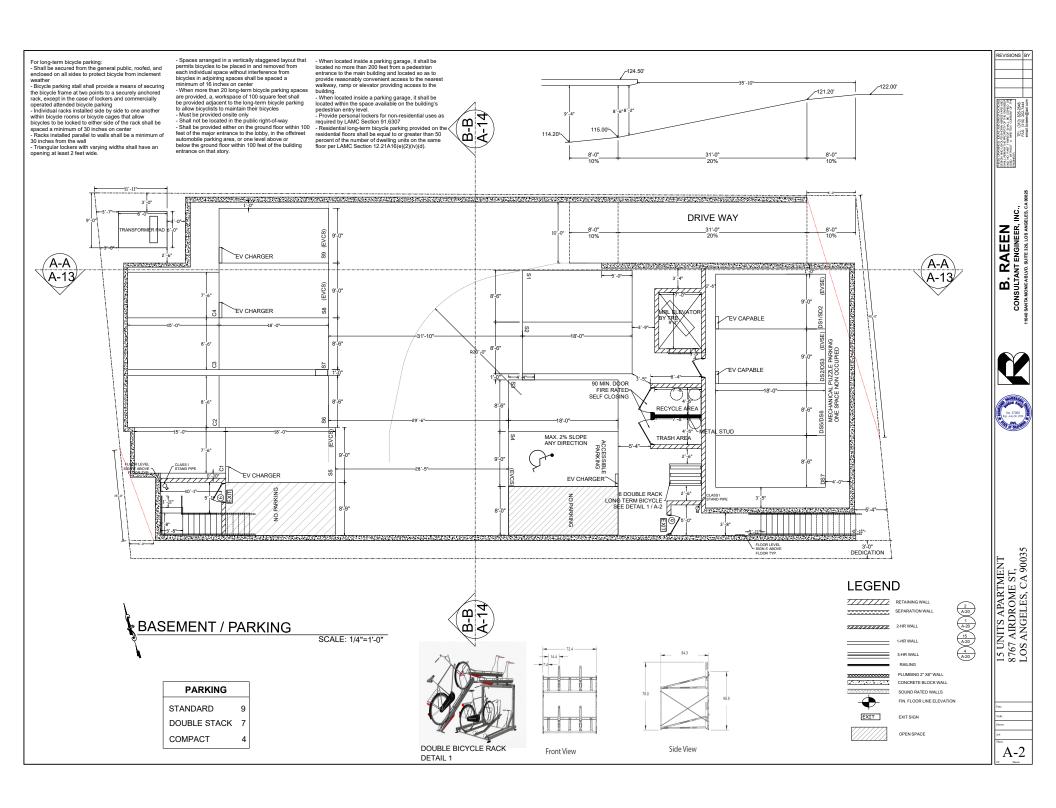
**STRUCTURAL** 


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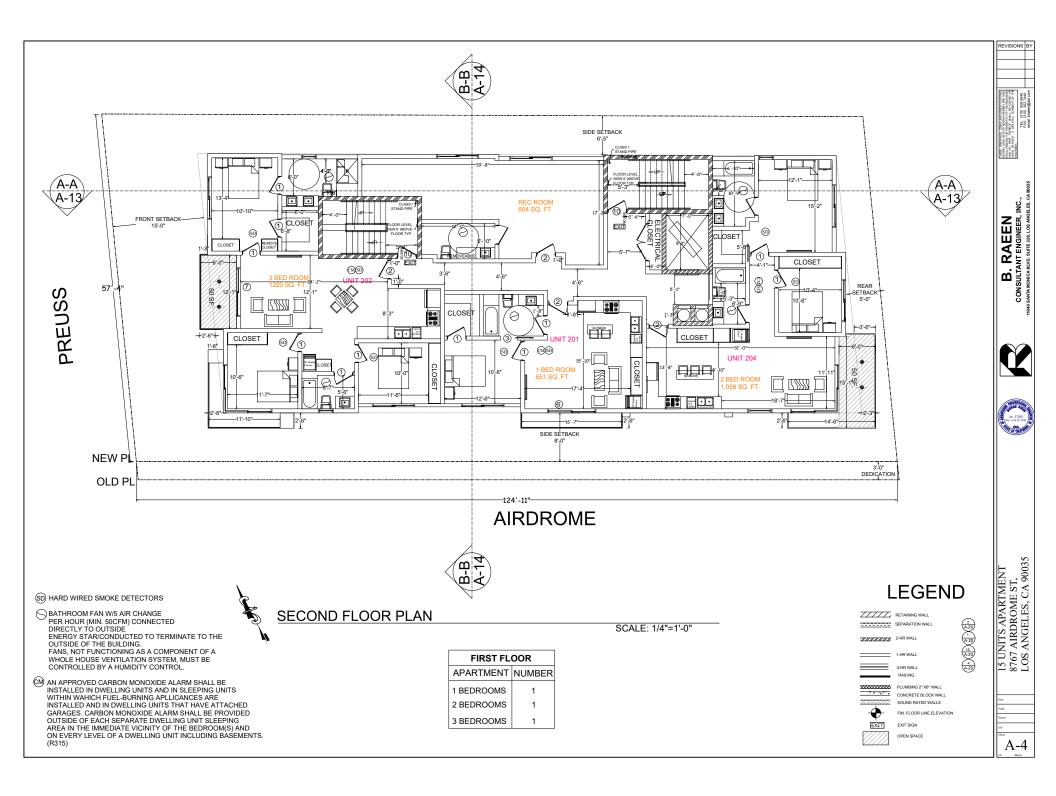
15 UNITS APARTMENT 8767 AIRDROME ST, LOS ANGELES, CA 9003;










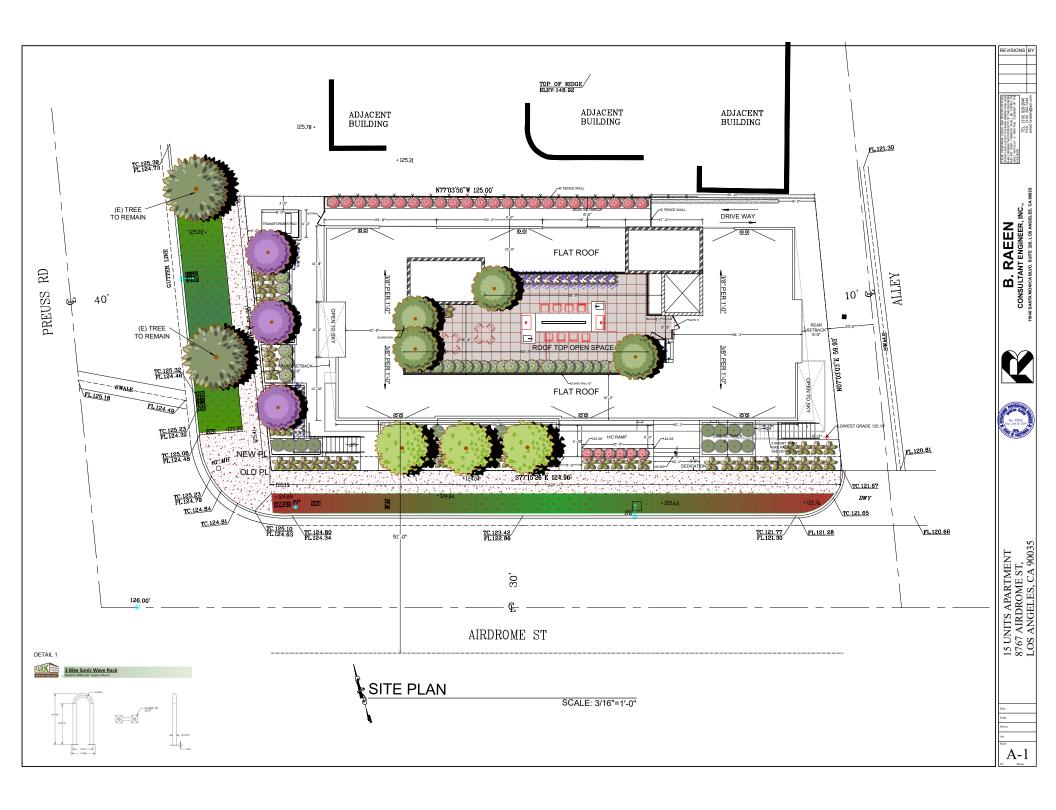


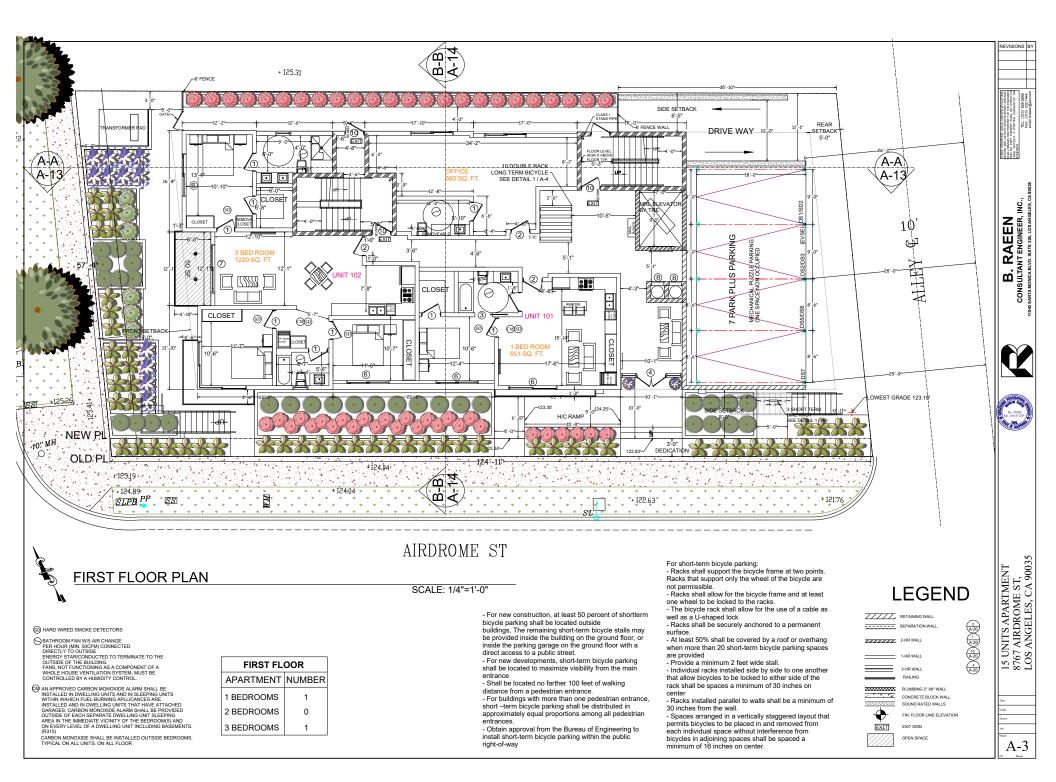

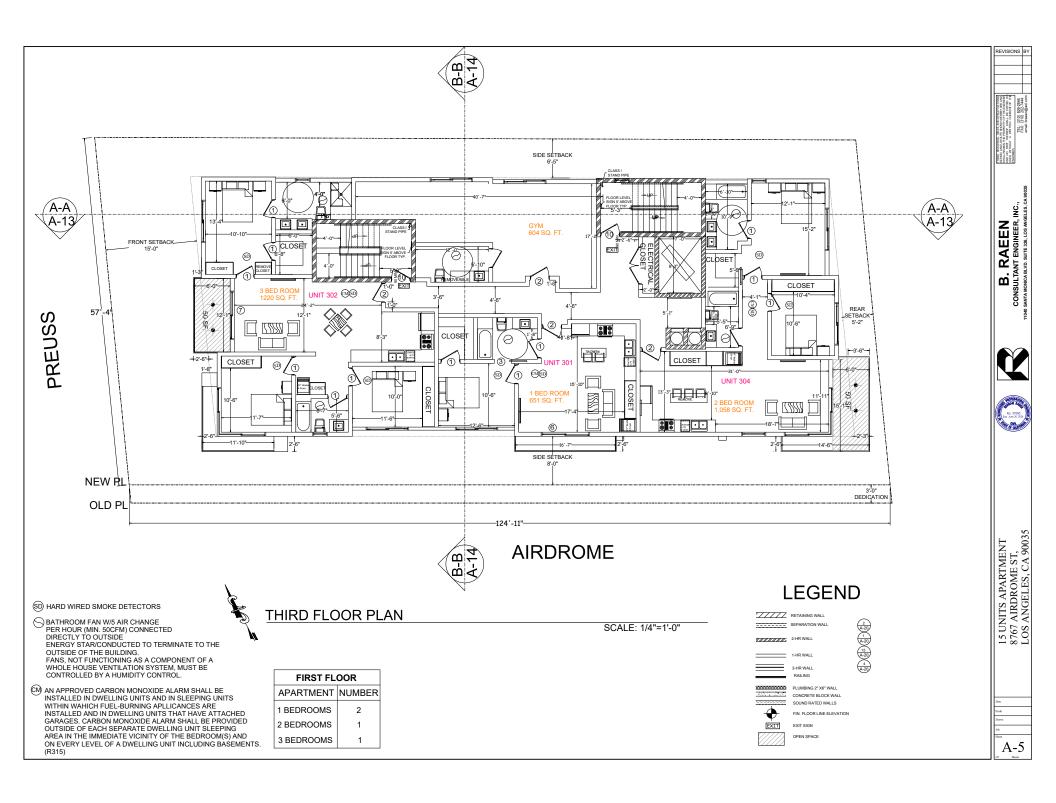

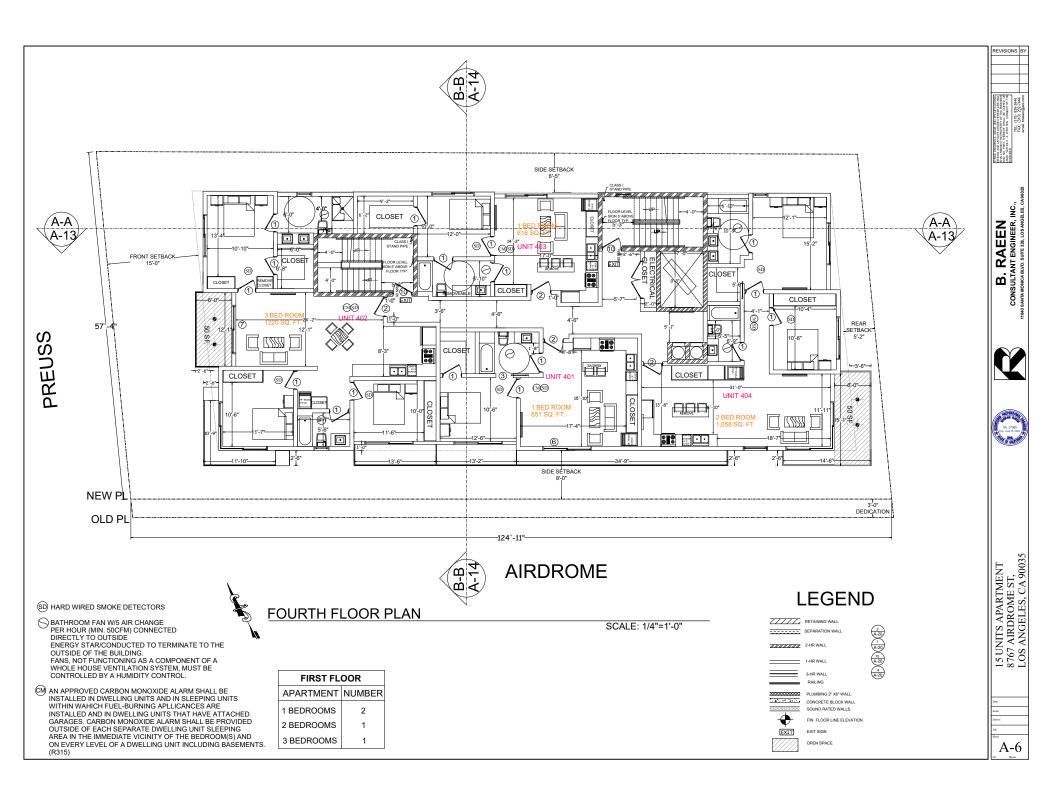

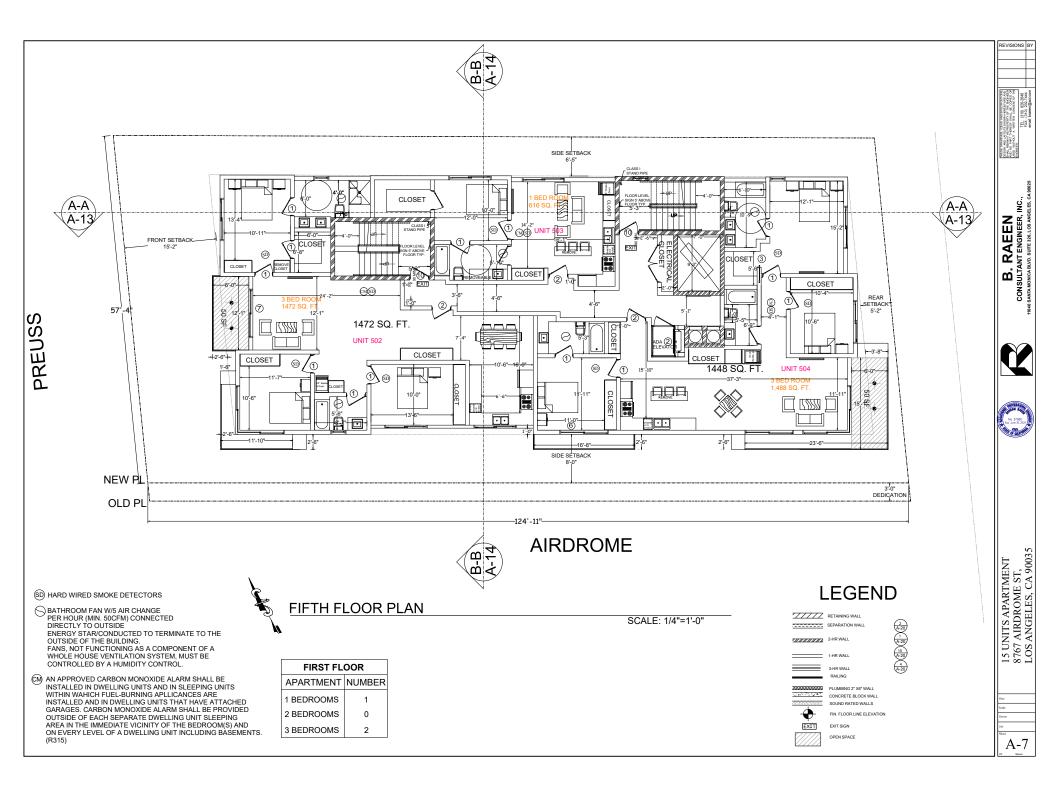

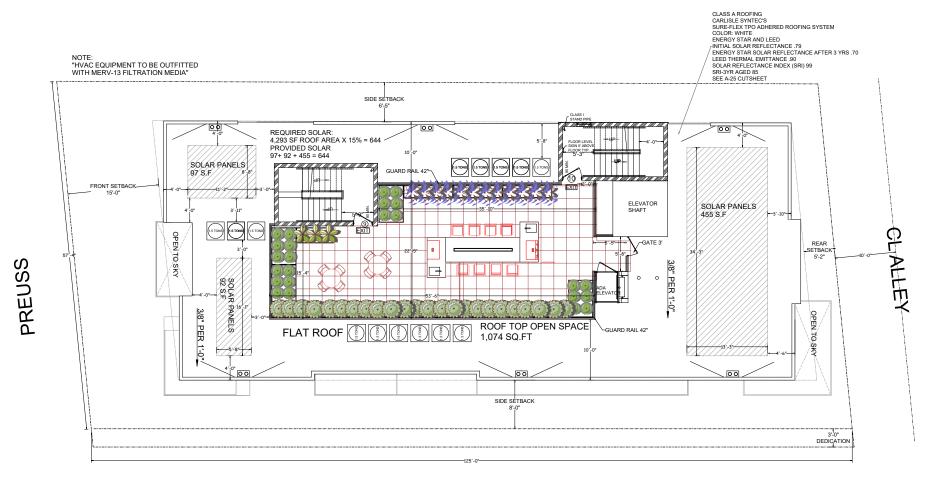

# **AIRDROME**

**ROOF PLAN** 

## **ENERGY EFFICIENCY**

10. For residential buildings, other than one- and two-family dwellings, comply with the following: a. Designate on the roof plan solar zone area(s) with total area equal to or greater than 15% of the building's roof area. The solar zone shall be comprised of areas that have no dimension less than 5 feet and each area shall not be less than:

i. 80 sq ft for roof areas of 10,000 sq ft or less

ii. 160 sq ft for roof areas over 10,000 sq ft.

b. For roof slopes > 2:12 (9.5° from horizontal), show that the solar zone is oriented between 110° and 270° of true north.

c. The solar zone shall be free of obstructions and be setback at least two times the height of any obstruction, including but not limited to, vents, chimneys, and equipment. d. For roof slopes ≤ 2:12, a minimum 4 foot center line axis pathway shall be provided on both axes of the roof.

e. For roof slopes ≤ 2:12, a minimum 4-foot straight line pathway shall be provided from the access path to roof standpipes, roof access hatches, skylights and/or ventilation hatches. f. For roof slopes ≤ 2:12, the solar zone shall allow for a (6-foot) (4-foot) wide clear perimeter access around the edges of the roof.

g. For roof slopes > 2:12, the solar zone not be located higher than 3 feet below the ridge and shall not be located closer than 18-inches to a hip or valley if placed on both sides of the hip or valley.

11. "A copy of the construction documents or a comparable document indicating the information from Energy Code Sections 110.10(b) through 110.10(c) shall be provided to the occupant." (Energy Code §110.10(d))



SCALE: 1/4"=1'-0"

REVISIONS B'

CONNECT TO A MODIFICATION OF A

RAEEN ANT ENGINEER, II B. CONSULTAR





A-8